





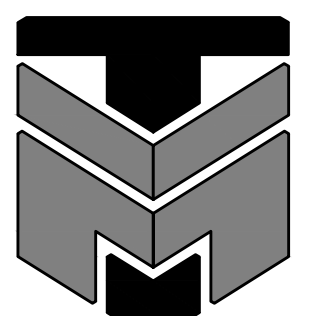

three inches = one foot
one and one half inches = one foot
one inch = one foot
three quarters inch = one foot
one half inch = one foot
three eighths inch = one foot
one quarter inch = one foot
one eighth inch = one foot

GENERAL NOTES:
A. READ SPECIFICATIONS FOR BALANCING DAMPER REQUIREMENTS.

- NOTES:**
(THIS SHEET ONLY)
- ① 44x22 SUPPLY DUCT UP THROUGH NEW CHASE TO AH-1-4SRF-1 ON ROOF. SEE SHEET M110 FOR CONTINUATION.
 - ② 28x18 SUPPLY DUCT UP THROUGH NEW CHASE TO AH-1-4SRF-1 ON ROOF. SEE SHEET M110 FOR CONTINUATION.
 - ③ PROVIDE DDC CONTROL PANEL FOR 3rd FLOOR AT THIS LOCATION.

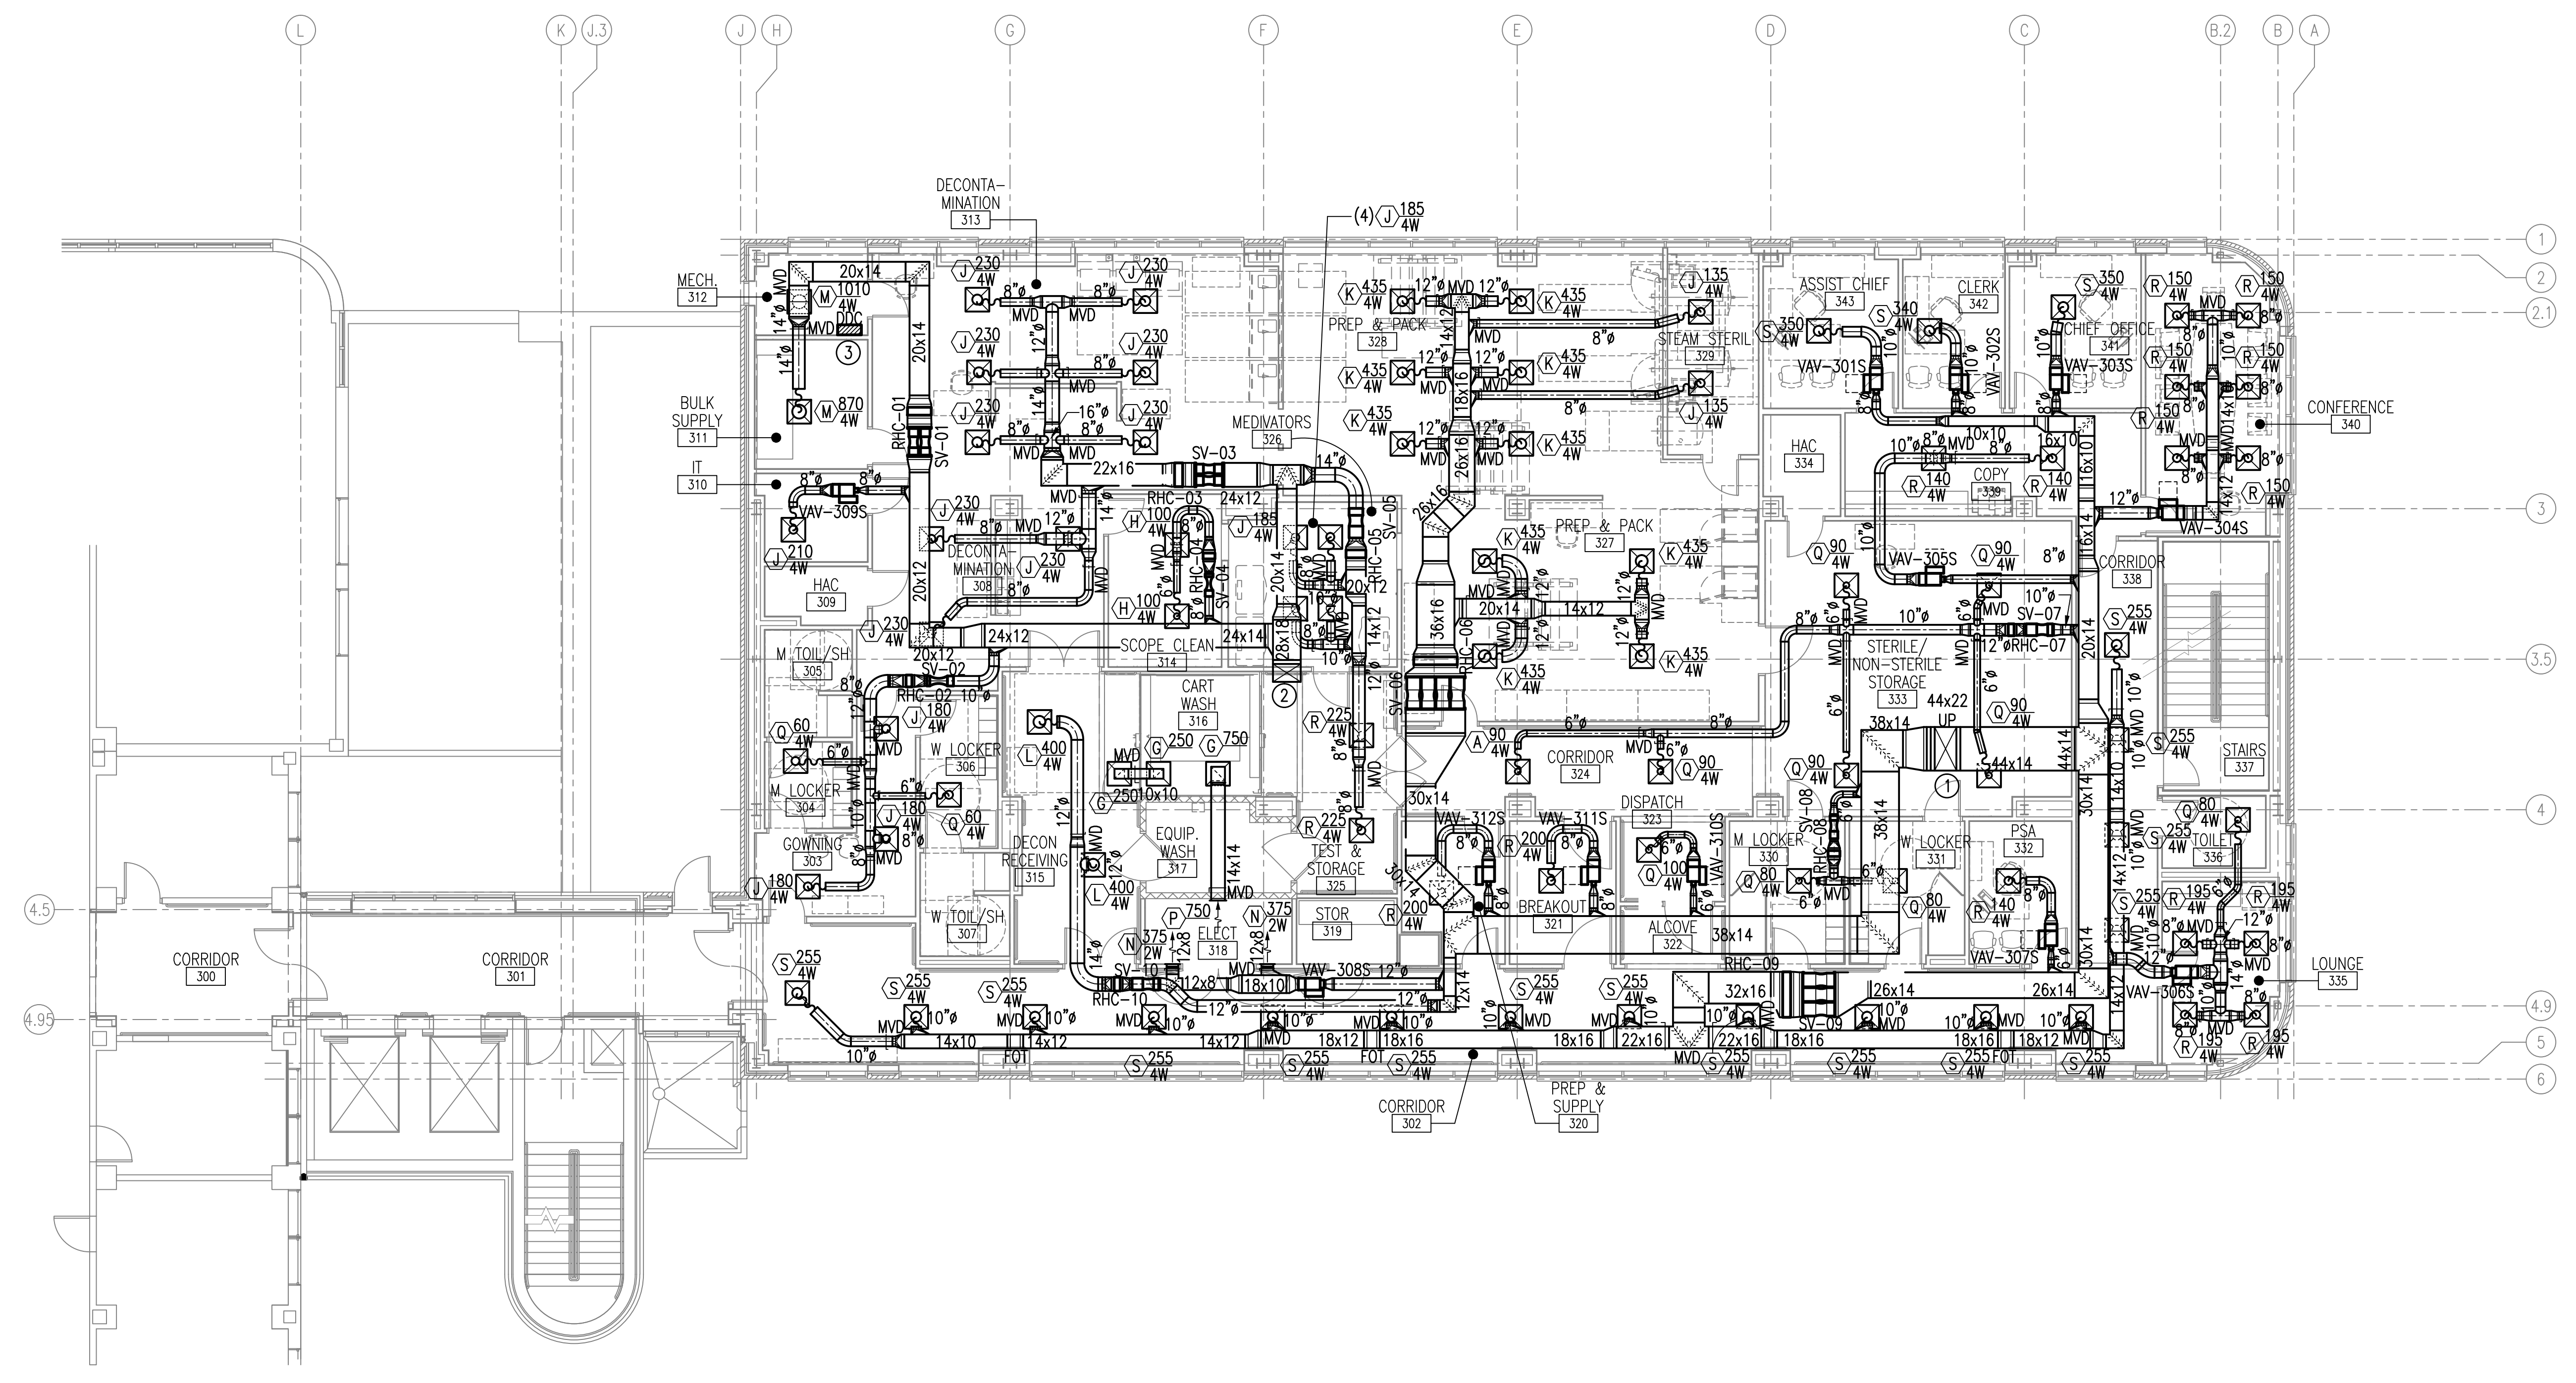

 **THIRD FLOOR SUPPLY DUCTWORK
NEW WORK PLAN - MECHANICAL**
SCALE: 1/8" = 1'-0"

<div>Revisions:</div> <table border="1"><tr><td> </td><td> </td></tr><tr><td> </td><td> </td></tr><tr><td> </td><td> </td></tr><tr><td> </td><td> </td></tr></table> <div>Date: </div>										<div>CONSULTANTS:</div> <div> APPLIED ENGINEERING SOLUTIONS 440 Martin Luther King, Jr. Blvd., Suite 401 Macon, Georgia 31201 Phone: (478) 314-1270 - Fax: (478) 314-1271 www.aes-pe.com</div>		<div></div>		<div>ARCHITECT/ENGINEERS:</div> <div> TOLAND MIZELL MOLNAR 590 Means Street NW, Suite 200 Atlanta, GA 30318 404.214.9774</div>		<div>Drawing Title:</div> <div>THIRD FLOOR SUPPLY DUCTWORK NEW WORK PLAN - MECHANICAL</div> <div>Approved: Project Director</div>		<div>Project Title:</div> <div>EXPAND RADIOLOGY AND SPS OVERTON BROOKS VAMC</div> <div>Location: SHREVEPORT, LA</div> <div>Date: 04-17-2015</div> <div>Checked: PJC</div> <div>Drawn: JSW</div>		<div>Project Number:</div> <div>667-083</div> <div>Building Number:</div> <div>1</div> <div>Drawing Number:</div> <div>M104</div> <div>Dwg. 109 of 160</div>		<div>FINAL SUBMITTAL</div> <div>OFFICE OF CONSTRUCTION AND FACILITIES MANAGEMENT</div> <div> U.S. Department of Veterans Affairs</div>	
VA FORM 08-6231																							